

Planning, Industry & Environment

-8 JAN 2020

**RECEIVED - JINDABYNE** 





SUBJECT SITE (KOSCIUSZKO CHALET HOTEL)



## KOSCIUSZKO CHALET·HOTEL

CHARLOTTE PASS · AUSTRALIA

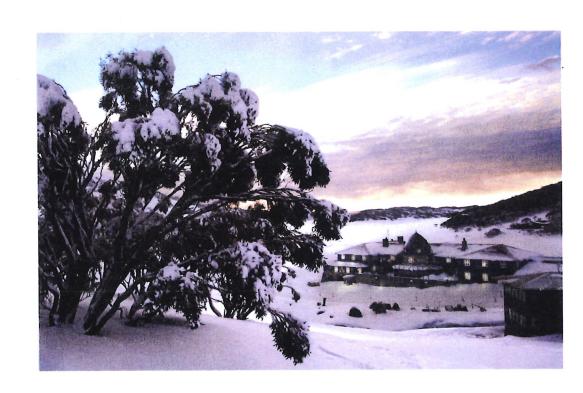

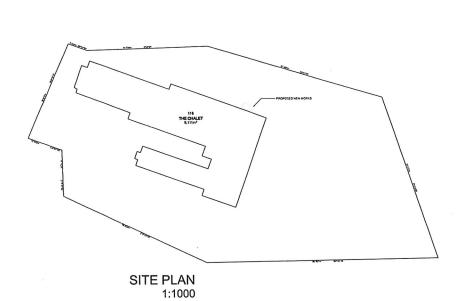

NOTE:- EXTERNAL FINISHES & COLOURS
TO BE IN ACCORDANCE WITH COUNCIL
CONDITIONS AND DEVELOPMENT CODES.

EROSION & SEDIMENT CONTROL NOTES:- "THE DEVELOPMENT WILL COMPLY WITH THE ENVIRONMENT PROTECTION GUIDELINES FOR CONSTRUCTION & LAND DEVELOPMENT.

blytongroup

Charlotte Pass

Architectural Drafting & Design ABN: 29 730 847 452

**ADDITION & DEMOLITION** to Cellar bar Portico Kosciuszko Chalet Hotel NSW Kosciuszko Road

For: Blyton Group PTY LTD

NOTES:
1: ALL WORKS ARE TO COMPLY WITH THE BCA & ALL RELEVANT AUTHORITY REQUIREMENTS.

2: ALL DIMENSIONS DEPENDENT ON EXISTING SITE CONDITIONS & SHALL BE VERIFIED BY THE BUILDER ON SITE PRIOR TO COMMENCEMENT OF ALL WORKS.

3: REGISTERED SURVEYOR TO SET OUT STRUCTURE & COMFIRM POSITION OF ALL RELEVENT BUILDING ENVELOPE SETBACKS & EASEMENTS OF THE WORKS.

4: THE STRUCTURE SHALL BE MAINTAINED IN A STABLE CONDITION AT ALL TIME, NO ELEMENT SHALL BE OVERSTRESSED, DURING & AFTER CONSTRUCTION.

5: THE BUILDER SHALL CHECK & VERIFY ALL DIMENSIONS ERRORS & OMISSIONS TO THE DESIGNER.

6: DO NOT SCALE OFF DRAWINGS, WRITTEN DIMENSIONS SHALL TAKE PRECEDENCE & THE BUILDER IS TO NOTIFY THE DESIGNER OF ANY DISCREPANCIES ON SITE.

7: ALL TRUSSES, LINTELS & CONNECTOR PLATES TO REGISTERED ENGINEERS SPECIFICATIONS.

8: ALL STORMWATER DRAINAGE TO BE CONNECTED INTO RELEVENT SERVICE LINE IN ACCORDANCE WITH BCA & LOCAL AUTHORITY REQUIREMENTS.

9: ALL TIMBER FRAMING & CONSTRUCTION MUST COMPLY WITH AS .1684 "THE NATIONAL TIMBER FRAMING CODE".

10: PROVIDE TEMPORARY & PERMANENT BRACING TO ALL FRAMING IN ACCORDANCE WITH THE BCA. TITLE PAGE **WD01** Checked by: Date: Thursday, 20 December 2018 DA DRAWINGS

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DO NOT SCALE OFF DRAWINGS. USE FIGURED DIMENSIONS. VERIFY ALL DIMENSIONS & NOTIFY DISCREPENCIES BEFORE PROCEEDING

- BLOCK BEARINGS, LENGTHS & CONTOURS HAVE BEEN DEPICTED FROM ORIGINAL DRAWINGS TO BE CONFIRMED BY BUILDER BEFORE ANY CONSTRUCTION HAS STARTED.

EROSION & SEDIMENT CONTROL NOTES:- "THE DEVELOPMENT WILL COMPLY WITH THE ENVIRONMENT
PROTECTION GUIDELINES FOR CONSTRUCTION & LAND DEVELOPMENT.

DATE DETAILS

GENERAL NOTES:
1. ARCHITECTURAL DRAWINGS SHALL BE READ IN CONJUNCTION WITH RELEVENT STRUCTURAL, HYDRAULIC, MECHANICAL, ELECTRICAL AND CIVIL WORKS DRAWINGS

2. ALL WORK WILL BE CARRIED OUT IN CONFORMITY WITH THE WATER AND SEWERAGE ACT 2000 AND THE WATER AND SEWERAGE REGULATIONS 2001.

3. ALL WORK SHALL BE CONSTRUCTED IN ACCORDANCE WITH AS3500.

4. THE LOCATION OF EXISTING SERVICES SHOWN WILL BE APPROCIMATE ONLY. EXACT LOCATIONS OF SERVICES TO BE VERIFIED PRIOR TO

5. MINIMUM GRADES ON 100mm AND 150mm DIAMETER STORMWATER DRAINS SHALL BE 1.00% UNLESS SHOWN OTHERWISE.

6. COVER LEVELS ON MANHOLES AND SUMPS TO BE VERIFIED BY THE SUPERINTENDENT PRIOR TO THE CONSTRUCTION OF TOP SECTIONS OF THE STRUCTURES. THE CONTRACTOR SHALL ALLOW CONSTRUCTION OF COVERS ON A SLOPE TO SUIT THE FINAL SURFACE SHAPES

7. ALL FLOOR WASTES ON SANITARY DRAINAGE LINES ANS PLANT ROOM SANITARY PLUMBING LINES SHALL BE 100mm X 100mr

8. WHERE UPVC PIPES PENETRATE FIRE WATED WALLS OR SLABS, THEY WILL BE PROVIDED WITH AN APPROVED FIRE RATED COLLAR, HAVING THE SAME FIRE RATING AS THE ELEMENT BEING PENETRATED.

9. WHERE SERVICES OTHER THAN uPVC PENETRATE CONCRETE OR MASONRY FIRE RATED BUILDING ELEMENTS, THE GAPBETWEEN SERVICES AND ELEMENT SHALL BE SEALED WITH AN APPROVED SILICON FIRE-STOP FOAM HAVING A FIRE RATING EQUAL TO THAT OF THE ELEMENT BEING PENETRATED.

10.SANITARY AND STORMWATER DRAINAGE IS TO BE SUPPORTED ON OR FROM SOLID GROUND IN ACCORDANCE WITH AS3500

11. ALL DRAINAGE AND EATER SERVICES IDENTIFIED TO BE ABANDONED SHALL BE SEALED TO APPROVAL.

11. EXISITING SERVICES CONNECTION POINT SHALL BE LOCATED ON SITE AND VERIFIED PRIOR TO COMMENCEMENT OF WORK.

PROPOSED NEW WORKS THE CHALET SITE PLAN 1:500

ALL TIMBER FRAMING AND CONSTRUCTION MUST COMPLY WITH THE CURRENT VERSION OF THE TIMBER FRAMING CODE AS1684 AND THE BCA

FOR EFFECTIVE ROOF LENGTH 8.400mm TO 11.100mm
90x35mm WALL PLATES (TOP & BOTTOM). PROVIDE DOUBLE 90x35mm
TOP PLATES TO LOAD BEARING WALLS

90x35mm STUDS AT 450mm CENTRES WITH ONE ROW OF NOGGING PROVIDE DOUBLE 90x35mm STUDS AT SIDES OF OPENINGS "GENERALLY" NON LOAD BEARING WALLS: 90x35mm STUDS AT 600mm CENTRES WITH ONE ROW OF NOGGING

ALL LINTELS SHALL COMPLY WITH TRUSS MANUFACTURERS CHARTS ROOF FRAMING:

PREFABRICATED TIMBER ROOF TRUSSES INSTALLED TO MANUFACTURERS SPECIFICATIONS

FRAMING TO AS1684-1992 NATIONAL TIMBER FRAMING CODE & SUPPLEMENTS. HARDWOOD TO AS3000.

ENGINEERING DOCUMENTATION TAKES PRECEDENCE OVER ARCHITECTURAL STRUCTURAL SIZINGS.

BRICKWORK TO AS3700 "SAA MASONRY CODE & AS1640" SAA BRICKWORK CODE STRUCTURAL STEEL TO AS1170 & AS4100. SMOKE ALARMS TO AS3786

## Notes:-

- All timber products as per FSC (Forestry Standards Council), PEFC (Programme for the Endorsement of Forest Certification) or AFS (Australian Forestry Standard) products with certified CoC (Chain of Custody) to merchant level? Note: illegal or old growth timbers are banned within CFSGAM

- All paint finishes are required to be low in Volatile Organic Compounds (VOCs). Note: this includes 2 pack and hand applied finishes.

- All graphics and signage substrates and inks are required to

be low in VOCs. - All lacquers, adhesives and sealants are required to be low in VOCs.

- Plasterboard Walls (not including landlord inter-tenancy walls) are to be recycled or recyclable

- All floor finishes are required to be low in VOCs.



- 8 JAN 2020

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NOTE:- EXTERNAL FINISHES & COLOURS TO BE IN ACCORDANCE WITH COUNCIL CONDITIONS AND DEVELOPMENT CODES.

NOTE:- ANY DAMAGE CAUSED TO THE SURROUNDING
PUBLIC INFRASTRUTURE INCLUDING STREET KERBING,
STREET TREES, FOOTPATHS, NATURE STRIPS (VERGE), SERVICES & ADJOINING LAND, AS A RESULT OF THE CONSTRUCTION OF THE RESIDENCE, IS TO BE REPAIRED & REINSTATED TO ITS ORIGINAL STATE BY THE BUILDER

ctural Drafting & Design

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6:- DO NOT SCALE OFF DRAWINGS, WRITTEN DIMENSIONS SHALL TAKE PRECEDENCE & THE BUILDER IS TO NOTIFY THE DESIGNER OF ANY DISCREPANCIES ON SITE.

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8:- ALL STORMWATER DRAINAGE TO BE CONNECTED INTO RELEVENT SERVICE LINE IN ACCORDANCE WITH BCA & LOCAL AUTHORITY REQUIREMENTS.
9:- ALL TIMBER FRAMING & CONSTRUCTION MUST COMPLY WITH AS :1684 "THE NATIONAL TIMBER FRAMING CODE".

10:- PROVIDE TEMPORARY & PERMANENT BRACING TO ALL FRAMING IN ACCORDANCE WITH THE BCA.

ARN: 29 730 847 452 Charlotte Pass blytongroup


SNOW RESORT

**ADDITION & DEMOLITION** to Cellar bar Portico Kosciuszko Chalet Hotel NSW Kosciuszko Road

For: Blyton Group PTY LTD

SITE PLAN **WD02** Checked by: awn by: 1:500 Date: Thursday, 20 December 2018 DA DRAWINGS 0030

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DATE

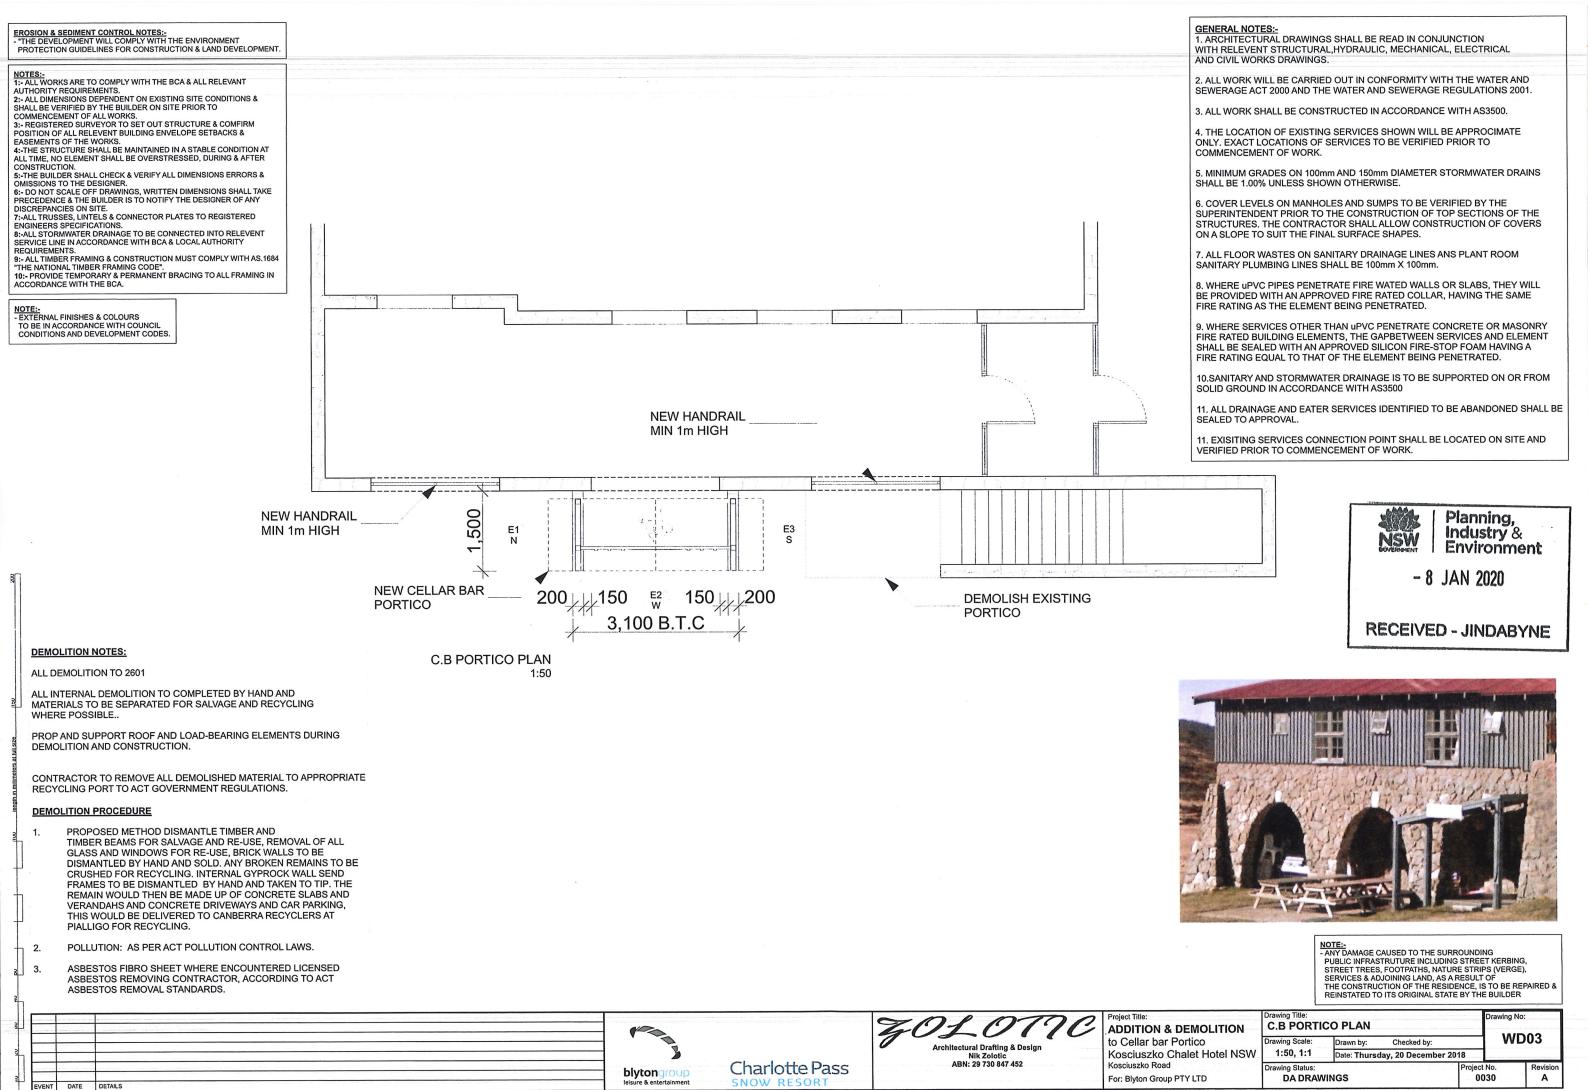DETAILS



**OPTION 3 3D-1** 1:250

Charlotte Pass

blytongroup

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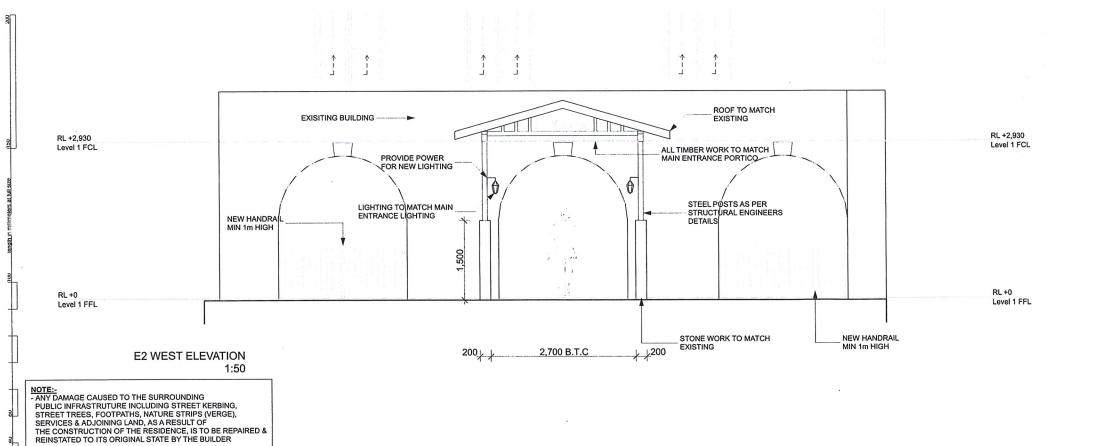
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Architectural Drafting & Design

ABN: 29 730 847 452

**ADDITION & DEMOLITION** to Cellar bar Portico Kosciuszko Chalet Hotel NSW Kosciuszko Road

Prawing Scale: 1:250, 1:50 awing Status

**ELEVATIONS, 3D VIEW WD04** Drawn by: Checked by: Date: Thursday, 20 December 2018

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